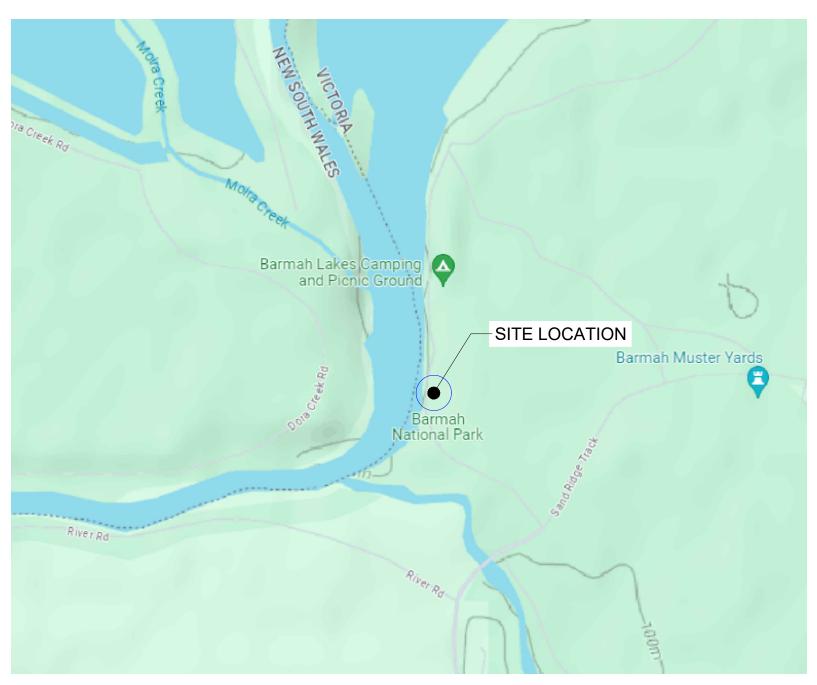
PARKS VICTORIA

MURRAY RIVER ADVENTURE TRAIL SECTION 8 BARMAH LAKES - KAYAK LAUNCH DESIGN

DRAWING INDEX

DRAWING NUMBER DRAWING DESCRIPTION JJR-4211023D-8-ST-ST001 COVER SHEET, LOCALITY PLAN & DRAWING INDEX JJR-4211023D-8-ST-ST002 SPECIFICATION AND NOTES JJR-4211023D-8-ST-ST003 SITE PLAN 3D VIEW JJR-4211023D-8-ST-ST004 JJR-4211023D-8-ST-ST005 DECK PLAN - TRANSFER PLATFORM, BENCH AND RAILING JJR-4211023D-8-ST-ST006 PREFABRICATED BENCH AND RAMP DETAILS DECK PLAN AND TRANSFER PLATFORM- PERIMETER FRAME JJR-4211023D-8-ST-ST007 AND STIFFENERS PLAN **DETAILS** JJR-4211023D-8-ST-ST008 JJR-4211023D-8-ST-ST009 **GANGWAY PLAN & SECTIONS** JJR-4211023D-8-ST-ST010 **DETAILS** ACCESS RAMP DETAIL JJR-4211023D-8-ST-ST011



LOCALITY PLAN

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RIGINAL 25					DESIGN LOT	CODE	PLOT DATE 09 February 2025	TIME 12:00:25	DESIGN MODEL	DESIGN MODEL FILE(S) USED FOR DOCUMENTATION OF THIS DRAWING				PARKS VICTORIA		
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E			B 02.04.2024	ISSUE FOR REVIEW	-	-	DRAFTER	H.GHORBANI								
190			C 03.04.2024	ISSUE FOR REVIEW	-	-	DRAFTING CHECK	N.CHUNG	~~~			SECTION 8				
				ISSUE FOR REVIEW	-	-			-	Darko	IIRYAN	AS SHOWN		BARMAH LAKES - KAYAK LAUNCH DESIGN		
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O A3			I 06.02.2025	ISSUED FOR TENDER	-	-	PROJECT MANAGER	T.BLINCO				CO-ORDINATE SYSTEM: MGA ZONE 55	HEIGHT DATUM: A.H.D.	TENDER	JJR-4211023D-8-ST-ST001	

APPROVAL FROM STRUCTURAL ENGINEER.

THE APPROVAL OF A SUBSTITUTION BY THE ENGINEER IS NOT AN AUTHORIZATION FOR AN VARIATION. ANY VARIATION INVOLVED MUST BE TAKEN UP WITH THE PRINCIPLE BEFORE WORK COMMENCES.

ALL DIMENSIONS SHALL BE VERIFIED ON SITE PRIOR TO FABRICATION.

EXCAVATIONS NEAR THE EDGE OF THE FOOTINGS ARE TO BE BACKFILLED AND COMPACTED IN SUCH A WAY AS TO PREVENT THE ACCESS OF WATER TO THE FOUNDATIONS.

SOIL STIFFNESS TO BE CONFIRMED AFTER GEOTECHNICAL INVESTIGATION.

THE BEARING CAPACITY OF THE SOIL BENEATH THE FOUNDATION SHALL BE AT LEAST 100

ALL WORKMANSHIP AND MATERIAL SHALL BE, BUT NOT LIMITED TO, THE FOLLOWING **AUSTRALIAN STANDARDS:**

WORK ITEM	RELEVANT AUSTRALIAN STANDARD
FOUNDATION & FOOTINGS	AS2159-2009
CONCRETE WORKS	AS3600-201
STRUCTURAL STEEL WORKS	AS4100-1998, AS4600-2005, AS1250
GUIDELINES FOR DESIGN OF	AS 3962
MARINAS	
GUIDELINES FOR THE DESIGN	AS 4997
OF MARITIME STRUCTURES	
(2005)	
(2000)	

A DIAL BEFORE YOU DIG (DBYD) SHOULD BE UNDERTAKEN PRIOR COMMENCEMENT OF ANY

10. THE STRUCTURAL WORK SHOWN ON THESE DRAWINGS HAS BEEN DESIGNED FOR THE **FOLLOWING ACTIONS:**

LIVE LOAD: PONTOON - 3 KPa, LIVE LOAD: GANGWAY - 4 KPa, ASSUMED WATER FLOW VELOCITY= 1 m/s FLOW LOAD= 0.7 kPa WIND LOAD:

BASIC WIND SPEED: 43m/s (ULS), 37m/s (SLS) - TC 2.5 ARI 2000y.

11. THESE DRAWINGS SHALL BE READ IN CONJUNCTION WITH ALL SPECIFICATIONS AND RELEVANT SOIL REPORT.

12. THESE DRAWINGS SHALL NOT BE SCALED.

13. THE FOLLOWING ACRONYMS ARE APPLIED AND RELEVANT TO ALL STRUCTURAL DRAWINGS:

14. SHS SQUARE HALLOW SECTION 15. EA EQUAL ANGLE

16. RC

REINFORCED CONCRETE

17. TYP TYPICAL

UNLESS NOTED OTHERWISE A.N.1.

CONCRETE

92

99

40

CONCRETE STRENGTH (AT 28 DAYS) SHALL BE:

- FOUNDATION ABUTMENT OF GANGWAY - 40MPa

- LEAN CONCRETE 20MPa

THE CONCRETE SLUMP SHALL BE IN ACCORDANCE WITH AS1379 WITH 20mm MAX NOMINAL SIZE, U.N.O.

CONSTRUCTION JOINTS WHERE NOT SHOWN SHALL BE PROPERLY FORMED AND LOCATED TO THE APPROVAL OF THE ENGINEER.

SPLICES IN REINFORCEMENT SHALL BE MADE ONLY IN POSITIONS SHOWN. WELDING OF BARS WILL NOT BE PERMITTED UNLESS SHOWN ON STRUCTURAL DRAWINGS.

REINFORCEMENT SHALL COMPLY TO AS1302, AS1303, AS1304 AS APPROPRIATE

N - DENOTES NORMAL DUCTILITY GRADE ON DEFORMED BAR TO AS4671

SL - DENOTES HARD-DRAWN WIRE FABRIC TO AS1304.

CONCRETE COVER TO BE MAINTAINED BY THE USE OF APPROVED BAR CHAIRS AT APPROX.

1000mm SPACING. CONDUITS, PIPES ETC. ARE NOT TO BE PLACED IN COVER CONCRETE POLYETHYLENE MEMBRANE TO BE APPROVED 0.2mm THICKNESS. MEMBRANE IS TO BE TAPED AROUND PIPES AND LAPPED A MINIMUM OF 200mm.

THE CONCRETE SHALL BE TRANSPORTED, PLACED, COMPACTED AND CURED IN ACCORDANCE WITH GOOD BUILDING PRACTICE.

CLEAR COVER TO FACE OF ALL REINFORCEMENT SHALL CONFORM TO THE FOLLOWING TABLE U.N.O. ON THE DRAWINGS:

REF	COVER (mm)
FOOTING	50

9. 0.2mm THICK WATER PROOF MEMBRANE TO BE PLACED UNDER ALL REINFORCED FOUNDATIONS. THE MEMBRANE TO BE LAPPED AND SEALED TO ENSURE MOISTURE

10. 'XYPEX ADMIX C-1000 NF' ADMIXTURE SHALL BE ADDED TO THE CONCRETE MIX AT THE TIME OF BATCHING FOR ALL LOWER LEVEL EXTERNAL REINFORCED CONCRETE . BEAMS AND FOOTINGS TO ENSURE CONCRETE IS COMPLETELY WATERTIGHT AND WATERPROOF.

11. EXTERNAL FACES OF ALL BELOW GROUND REINFORCED CONCRETE SHALL BE SEALED BY: DUROMASTIC BLW LIQUID BITUMEN RUBBER MEMBRANE (DUROTECH INDUSTRIES OR SIMILAR APPROVED).

9mm VILLA BOARD OVER PLATON-DOUBLE DIMPLE HDPE MEMBRANE (CEMENTAL & ACE WATERPROOFING PTY LTD) OR SIMILAR APPROVED

12. SPECIFICATION & MANUFACTURING OF CONCRETE SHALL BE IN ACCORDANCE WITH AS1379.

13. SAMPLING & TESTING OF CONCRETE SHALL BE IN ACCORDANCE WITH AS3600.

14. FORMWORK & ITS REMOVAL SHALL BE IN ACCORDANCE WITH AS3610.

15. SURFACE FINISHES SHALL BE IN ACCORDANCE WITH AS3610.

16. CONSTRUCTION TOLERANCES SHALL BE IN ACCORDANCE WITH AS3600, CLAUSE 17.5

STRUCTURAL STEELWORK

ALL STEELWORK SHALL BE IN ACCORDANCE WITH AS4100 AND AS4600.

ALL WELDING SHALL COMPLY TO AS1554.

WELDS SHALL BE 6mm CONTINUOUS FILLET WELD UNLESS OTHERWISE NOTED.

BLACK BOLTS IN 2mm CLEARANCE HOLES ARE TO BE USED U.N.O.

ALL BOLTS, SCREWS, NUTS AND WASHERS TO BE HOT DIP GALVANISED

THE CONTRACTOR SHALL PROVIDE AND LEAVE IN PLACE UNTIL PERMANENT BRACING ELEMENTS ARE CONSTRUCTED, SUCH TEMPORARY BRACING AS IS NECESSARY TO STABILISE THE STRUCTURE DURING ERECTION.

ALL EXTERNAL STEEL MEMBERS SHALL BE HOT DIPPED GALVANISED.

ALL OTHER STEEL MEMBERS ARE TO BE TREATED BY REMOVING LOOSE SCALE BY HAND OR POWER WIRE BRUSHING AND COATED WITH A RUSH INHIBITIVE ALKYD PRIMER OR **EQUIVALENT**

ROLLED SECTIONS TO BE GRADE 300+ (U.N.O.) / CONNECTION PLATES TO BE GRADE 250, AND HOLLOW SECTIONS TO BE GRADE 350.

10. HIGH STRENGTH BOLTING SHALL BE IN ACCORDANCE WITH AS1511

11. BOLTS MARKED 4.6/S SHALL BE MILD STEEL BOLTS INSTALLED SNUG TIGHT. BOLTS MARKED 8.8/S SHALL BE HIGH STRENGTH BOLTS INSTALLED SNUG TIGHT. BOLTS MARKED 8.8/T SHALL BE HIGH STRENGTH BOLTS FULLY TORQUED IN ACCORDANCE WITH AS4100 ie. SNUG TIGHT PLUS ONE HALF TURN. ALL BOLTS, NUTS, WASHERS AND METHODS OF INSTALLATION etc. TO BE IN ACCORDANCE WITH THE RELEVANT AUSTRALIAN STANDARDS.

ALL STRUCTURAL WORK TO BE PROTECTED AGAINST CORROSION IN ACCORDANCE WITH THE BCA CLAUSES 3.4.4.4 TABLE 3.4.4.2.

ALL WELD CATEGORY TO BE SP.

14. WELDING ELECTRODES TO BE E48XX IN ACCORDANCE WITH AS1553.1.

ALL BUTT WELDS TO BE FULL PENETRATION CONTINUOUS.

COMPONENTS TO BE CAST IN CONCRETE TO BE HOT DIP GALVANISED TO AS1650 AFTER **FABRICATION**

17. HOLE DIAMETER TO BE BOLT DIAMETER PLUS 2mm FOR ALL BOLTED CONNECTIONS U.N.O.

18. ALL BOLTS TO BE HIGH STRENGTH GRADE 8.8 UNLESS NOTED OTHERWISE.

19. STEEL PURLINS SHALL BE COLD FORM SECTION AND COMPLY WITH AS1397 WITH MINIMUM GRADE OF G450.

20. ZINC COATING OF Z350 (350g/m³ MINIMUM COATING MASS) SHALL BE USED FOR ALL PURLINS AND GIRTS

21. THE PILES ARE TO BE STEEL CHS PILES WITH HDPE MEMBRANES.

22. ALL STEEL MEMBERS SHALL BE OF GRADE G350 STEEL

STRUCTURAL ALUMINUM WORK

ALL STRUCTURE IS FULLY WELDED WITH A FILLET OF 5mm. FILLER ALLOY IS GRADE 5356.

ALL ESTRUSIONS ARE GRADE 6063-T5 OR EQUIVALENT.

ALL 100x50x3 RHS ARE TO HAVE 3MM RADIUS EDGE.

ALL FASTENERS ARE CORROSION RESISTANT STEEL

ALL EXPOSED BOLTS ARE TO BE RECESSED INTO THE TIMBER BY COUNTER BORING.

ALL BOLT THREADS ARE TO BE TREATED WITH ANTI-SEIZE OR EQUIVALENT LUBRICATING COMPOUND PRIOR TO FASTENING.

ALL 100x50x3 RHS ARE TO HAVE 6MM RADIUS EDGE

ALL OTHER RHS ARE TO HAVE 3MM RADIUS EDGE.

ALL ALUMINIUM STRUCTURES SHALL BE FABRICATED AND ERECTED IN ACCORDANCE WITH AS/NZS 1664:1997

1200 LITER FLOTATION MODULE WORKS

FLOTATION MODULES ARE MANUFACTURED BY ROTATIONAL CASTING.

FLOTATION MODULES ARE MANUFACTURED FROM U.V. STABILISED, HIGH STRESS CRACK RESISTANT, LINEAR POLYETHYLENE.

STANDARD COLOR BLACK

FLOATS CAN BE FILLED WITH WATER OR CONCRETE TO ADD BALLAST TO INCREASE STABILITY. BALLAST CAN ALSO BE USED TO RAISE AND LOWER THE FLOAT FOR DIFFERENT FREEBOARD REQUIREMENTS. FLOATS CAN ALSO BE FOAM FILLED FOR EXTRA SECURITY IF REQUIRED

STANDARD FLOATS ARE HOLLOW.

FLOATS CAN ALSO BE FOAM-FILLED FOR EXTRA SECURITY IF REQUIRED. FOR ADDITIONAL FLOTATION SECURITY, FLOATS CAN BE FOAM FILLED. WHEN FOAM-FILLED, THEY CAN TAKE UP TO 800KG EACH. DIMENSIONS: 2000MM LONG X 1200MM WIDE X 520MM DEEP. PRODUCT WEIGHT: 62KG (HOLLOW) AND 105KG (FOAM-FILLED).

DUE TO THE MANUFACTURING PROCESS, FLOAT DIMENSIONS MAY VARY

THE FLOATS WILL BE FILLED WITH WATER TO ATTAIN A FREEBOARD OF 350 MM, THEREBY ENHANCING STABILITY.

TIMBER

1. ALL MULTIPLE MEMBERS TO BE NAIL LAMINATED AS PER REQUIREMENTS OF AS1684-2010.

ALL TIMBER ELEMENTS TO BE F17.

WHEN USING TREATED PINE REFERENCE IS TO BE MADE TO THE MANUFACTURER'S SAFETY DATE SHEET(MSDS).

TIMBER SHALL BE STORED AND HANDLED SO AS NOT TO BE DETRIMENTAL TO THEIR PERFORMANCE OR DAMAGE THEM. REFER TO APPENDIX C AS1684-2010.

ALL TIMBER SHALL BE DRY, ie: LESS THAN 15% MOISTURE CONTENT AT THE TIME OF CONSTRUCTION AND SHALL BE PROTECTED AND/OR TREATED.

ALL TIMBER IS TO BE TREATED WITH A SUITABLE PRESERVATIVE. (DECKING OIL, ETC).

ALL TIMBER MOORING POSTS SHALL BE OF F17 GRADE TIMBER, AS PER AS 1720.1.

ENVIRONMENTAL

PARKS VICTORIA IS RESPONSIBLE FOR OBTAINING ALL NECESSARY ENVIRONMENTAL PERMITS PRIOR TO COMMENCING WORKS.

PARKS VICTORIA SHALL PROVIDE AN ALLOWANCE FOR ALL REQUIRED **ENVIRONMENTAL CONTROLS WITHIN THEIR TENDER PRICE**

ALL DISTURBED AREAS SHALL BE STABILISED (ie. TOPSOIL & TURF) AS SOON AS **PRACTICAL**

SOIL CONDITIONS

FURTHER INSPECTION & SOIL INVESTIGATION WORKS SHALL BE UNDERTAKEN WHEN EARTHWORKS COMMENCE PRIOR TO FOUNDATION REPLACEMENT AND PILE DRIVING.

THE PILE CAPACITIES ARE TO BE DETERMINED BASED ON THE GEOTECHNICAL SPECIFICATION

EXISTING SERVICES

THE CONTRACTOR SHALL VERIFY ALL DIMENSIONS, LOCATION AND LEVEL OF ALL EXISTING SERVICES ON SITE PRIOR TO COMMENCING CONSTRUCTION. ALLOW FOR ANY PROTECTION TO EXISTING SERVICES REQUIRED BY AUTHORITIES. ANY SERVICE DAMAGED BY THE CONTRACTOR SHALL BE REINSTATED AT THE CONTRACTORS EXPENSE.

SITE MAINTENANCE

1. ALL DEBRIS, BUILDING RUBBLE, SURFACE VEGETATION AND TOP SOIL SHALL BE REMOVED FROM THE AREA BENEATH CONCRETE SLABS POURED ON GROUND.

SERVICE TRENCHES

ENSURE ALL SERVICE TRENCHES ARE MAINTAINED AT LEAST THE DEPTH OF THE EXCAVATION AWAY FROM THE FOOTINGS. CONTACT THIS OFFICE IMMEDIATELY IF THIS CANNOT BE ACHIEVED.

LEGEND

THE FOLLOWING LEGEND APPLIES TO ALL STRUCTURAL DRAWINGS:

FRP GRATING **PVC WITH UV TIMBER**

NOT FOR CONSTRUCTION

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5			С	03.04.2024	ISSUE FOR REVIEW	-	-	DRAFTING CHECK	N.CHUNG	
_			D	09.04.2024 29.04.2024	ISSUE FOR REVIEW ISSUE FOR REVIEW	-	-	DESIGNER	P.SHABANPOUR	1
2			F	29.04.2024	ISSUE FOR REVIEW	-		DESIGN CHECK	N.CHUNG	
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0			- 1	06.02.2025	ISSUED FOR TENDER	-	-	PROJECT MANAGER	T.BLINCO	

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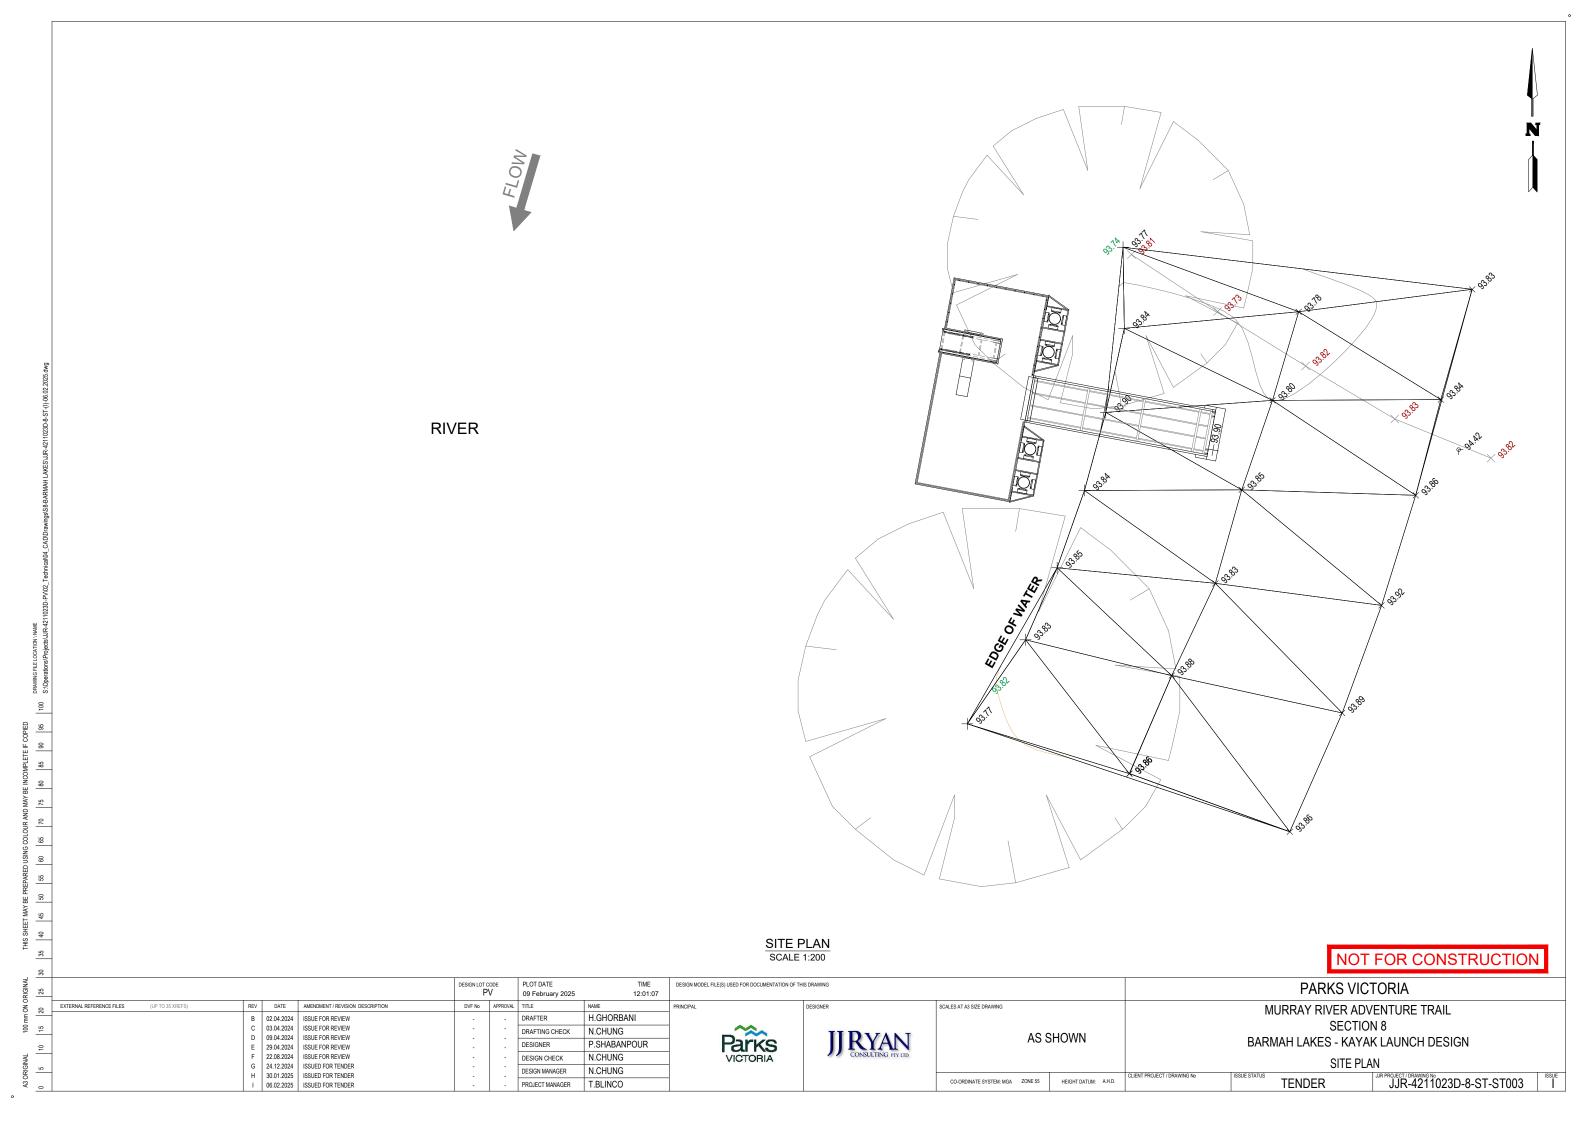
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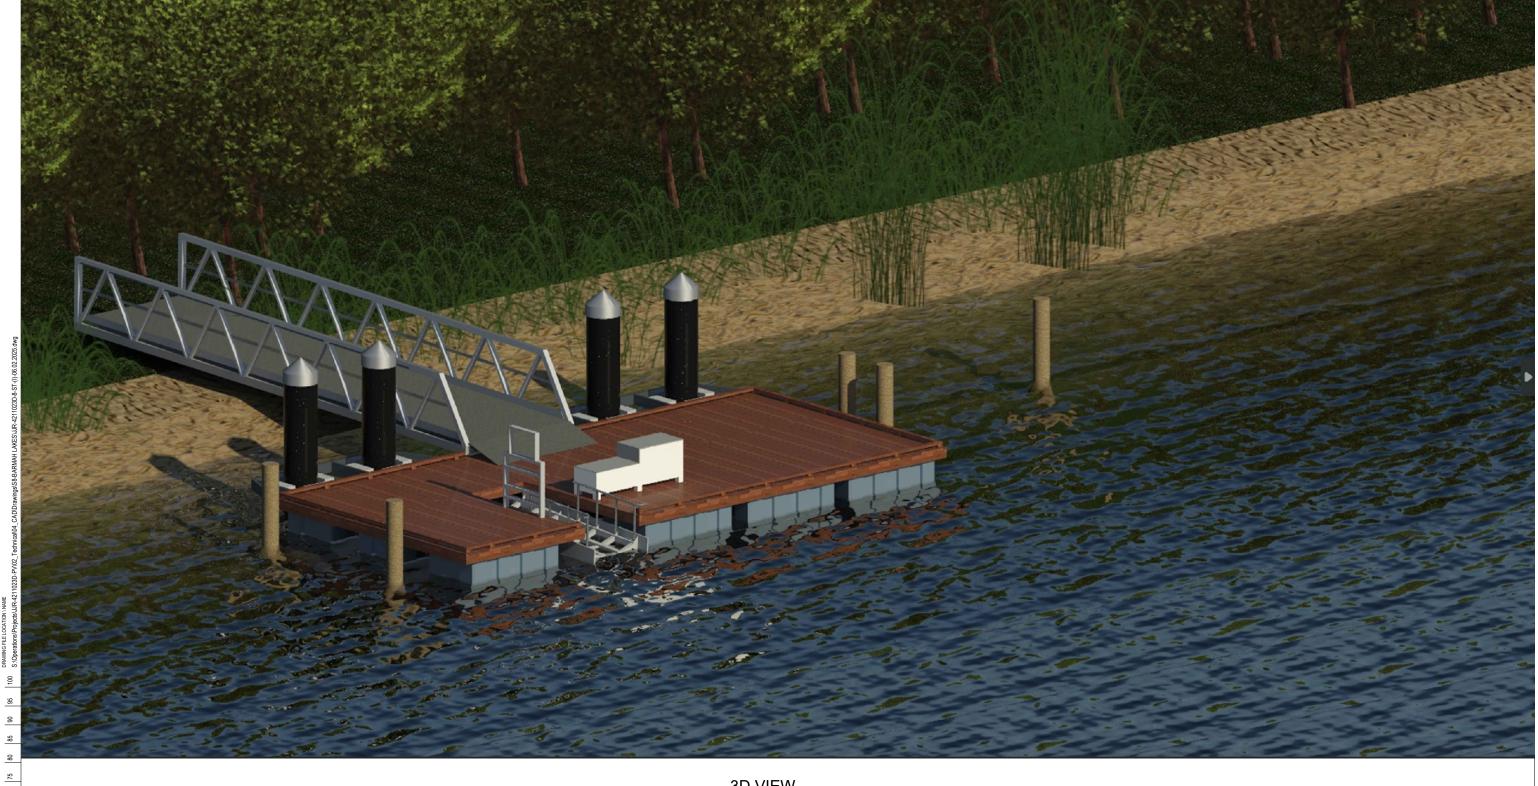
MURRAY RIVER ADVENTURE TRAIL SECTION 8 BARMAH LAKES - KAYAK LAUNCH DESIGN

PARKS VICTORIA

SPECIFICATION AND NOTES

JJR-4211023D-8-ST-ST002 **TENDER**

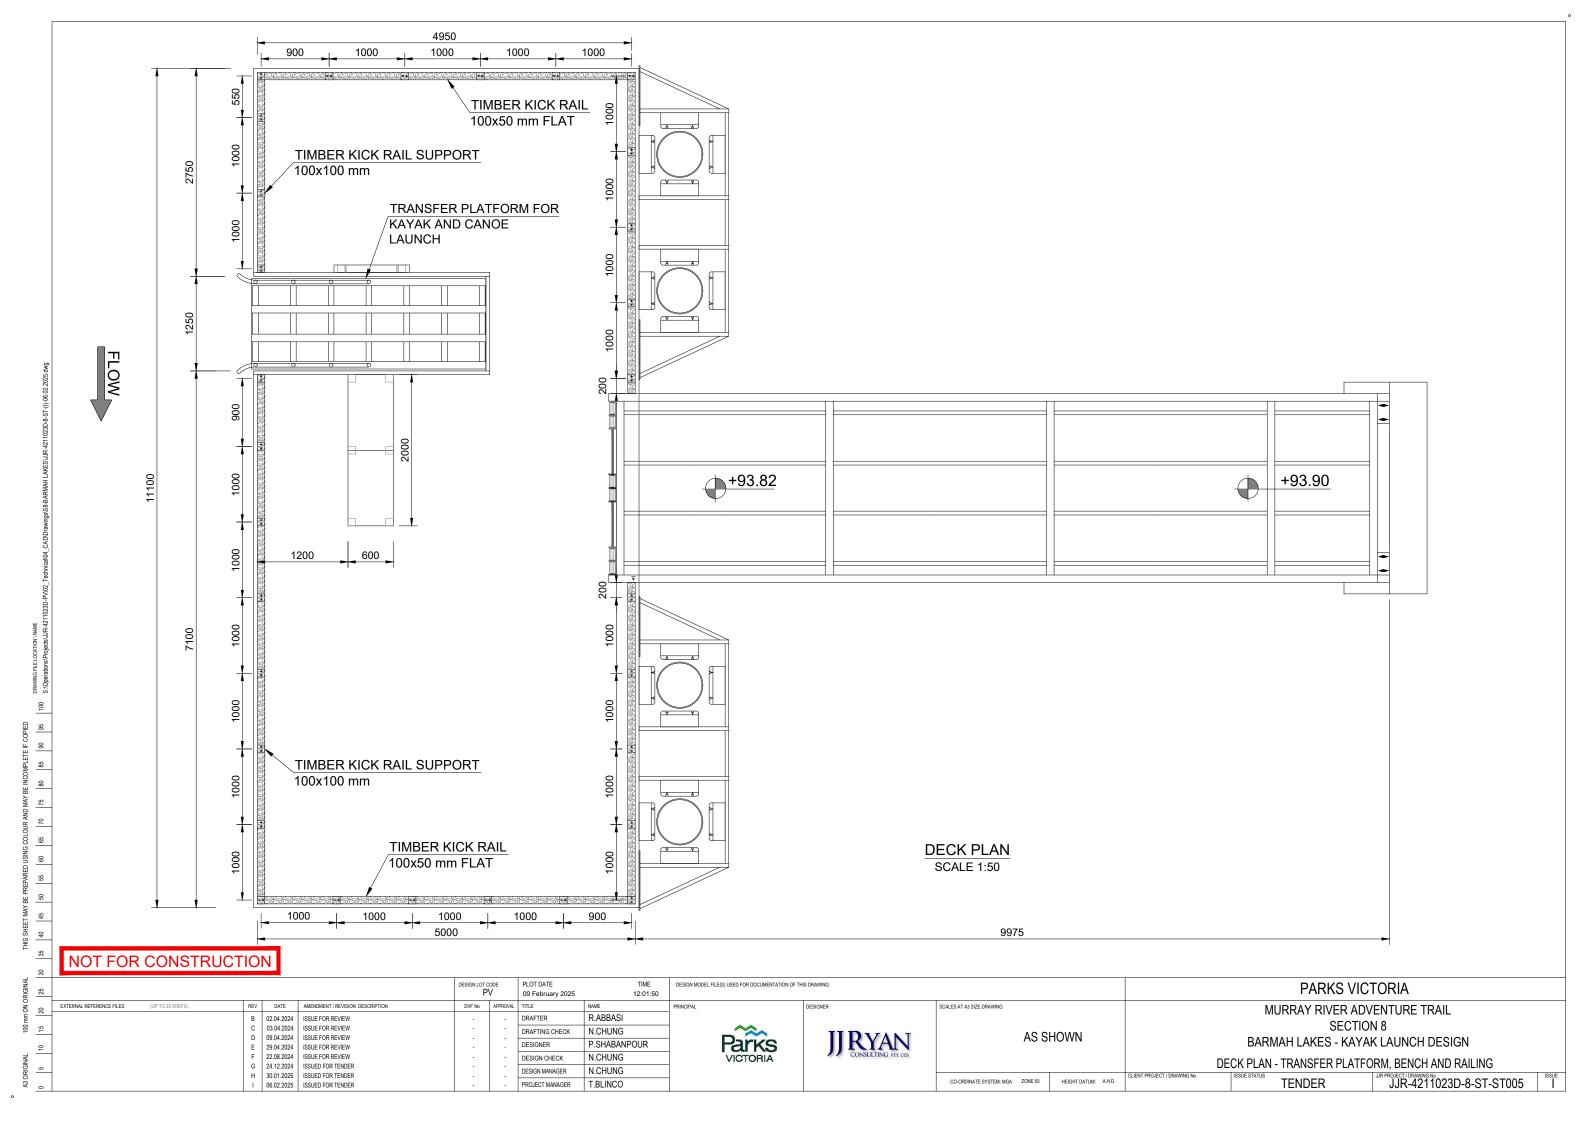


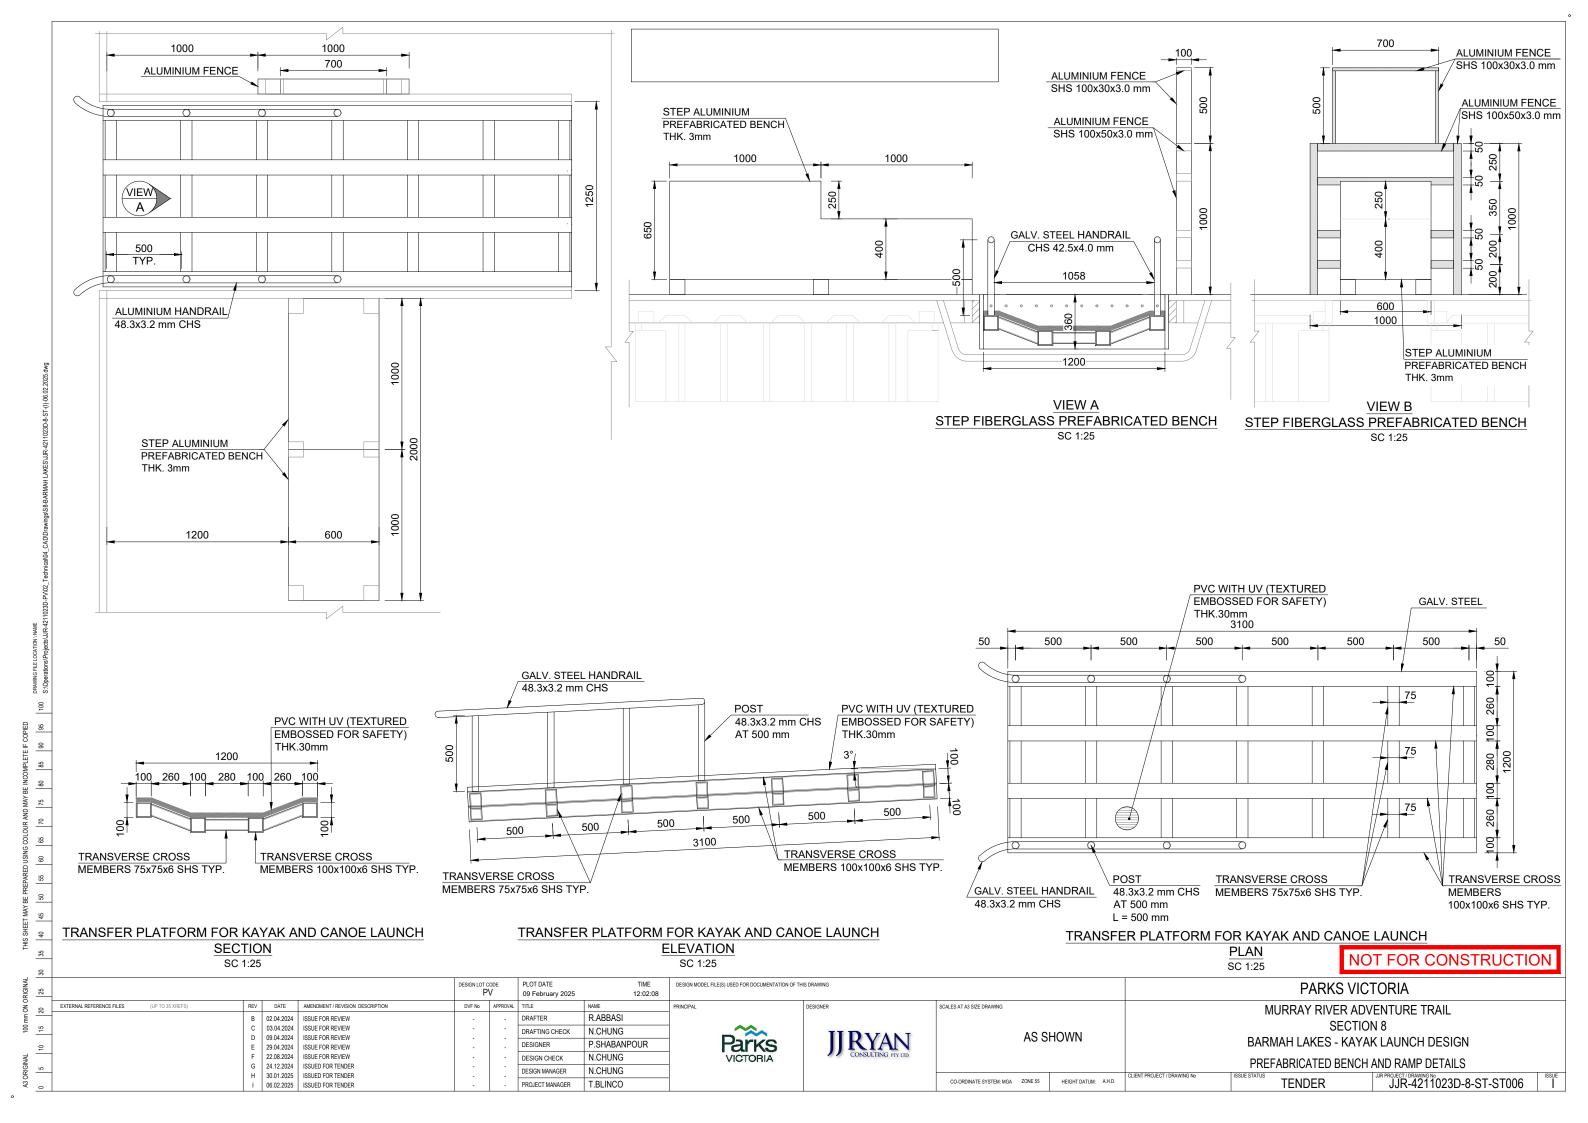


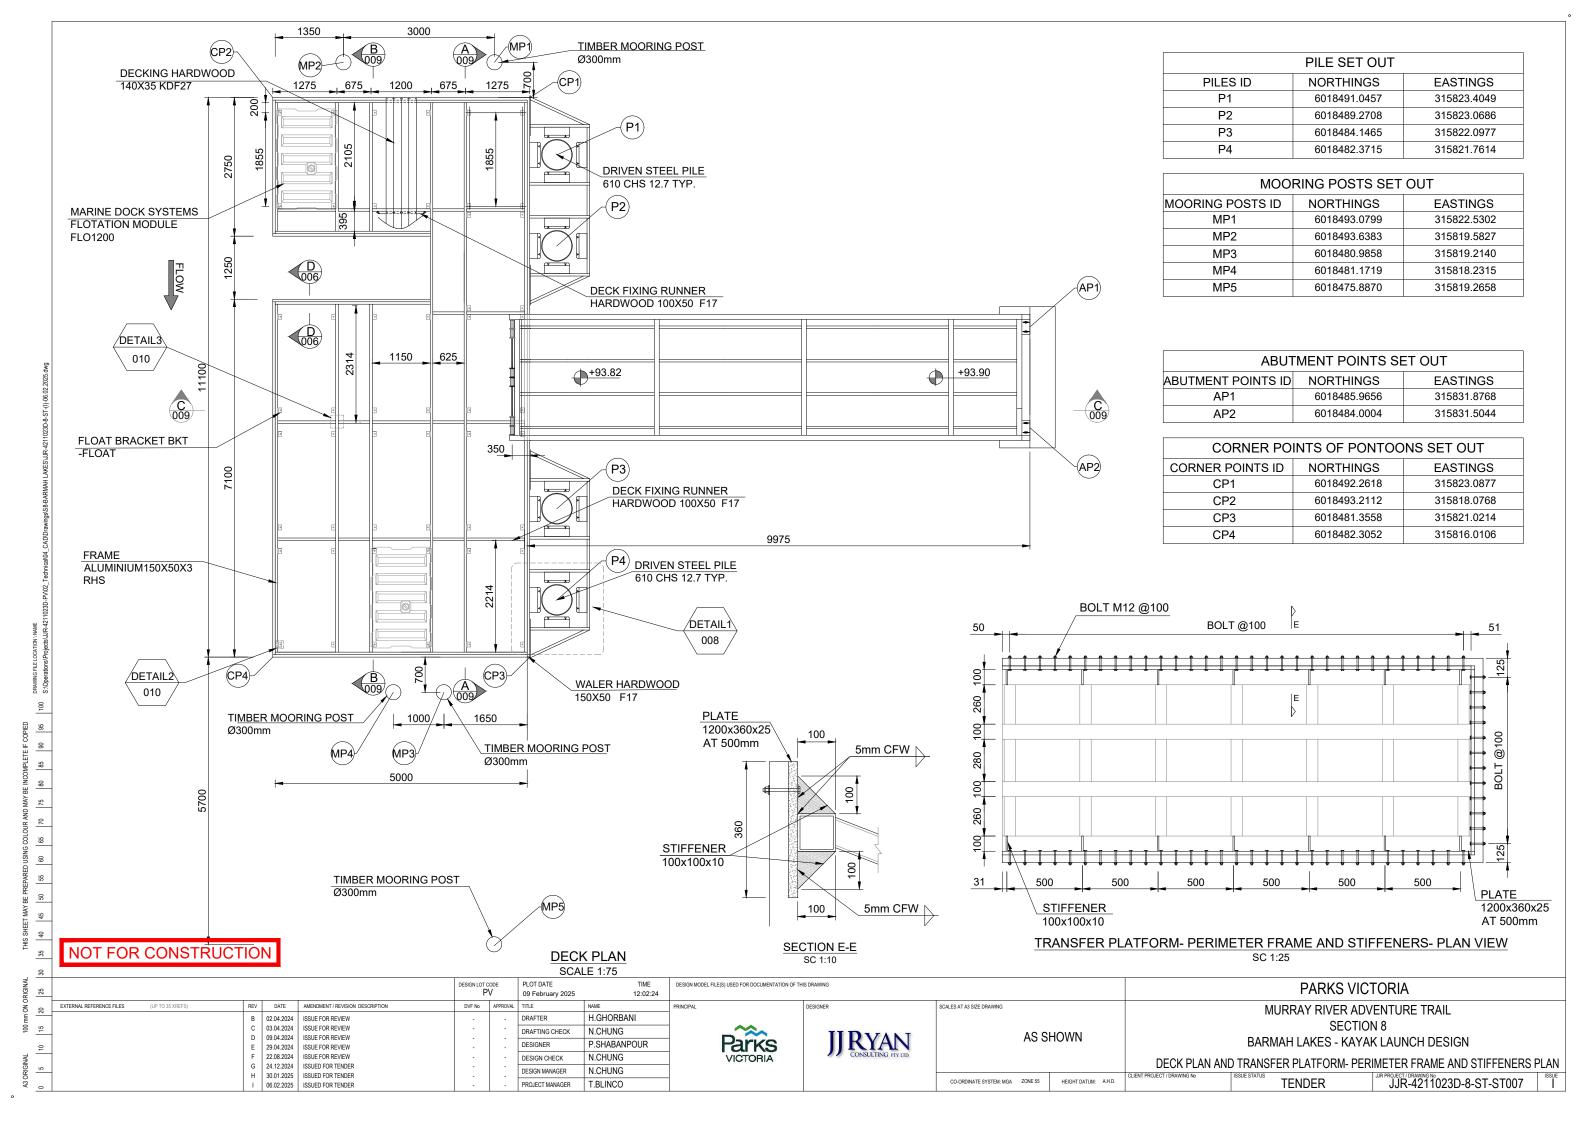
 $\frac{\text{3D VIEW}}{\text{N.T.S.}}$

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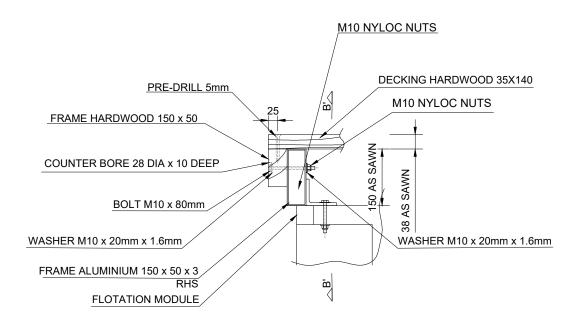




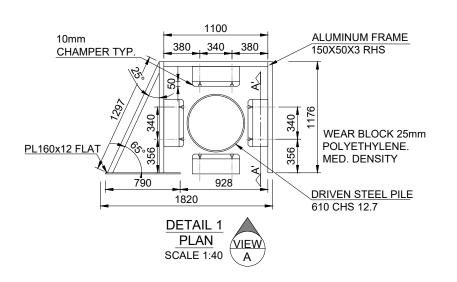
TIMBER MOORING POST

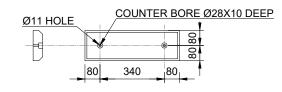
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SC 1:10



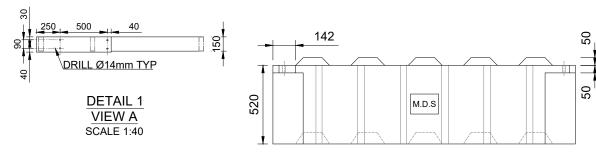
TYPICAL SECTION FOR FLOTATION MODULE AND DECK ASSEMBLY SECTION D-D SCALE 1:10





POLYETHYLENE WEAR BLOCK MDPE FOR POLY SLEAVES AND EPOXY COATED PILES

> DETAIL 1 SECTION A'-A' SCALE 1:20





FLOTATION MODULE 1200 LITER SECTION

SCALE 1:25

WASHER M10 x 20mm x 1.6mm

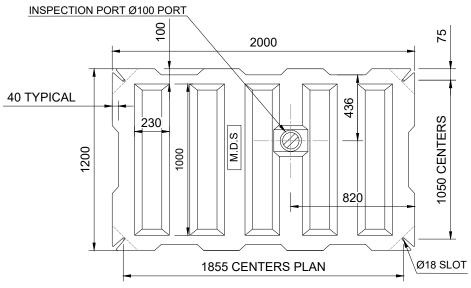
CKT-FLOAT

BOLT M10 x 80mm

M10 NYLOC NUTS

FLOAT NOT SHOWN IN THIS VIEW

SECTION B'-B' SCALE 1:10



FLOTATION MODULE 1200 LITER

PLAN

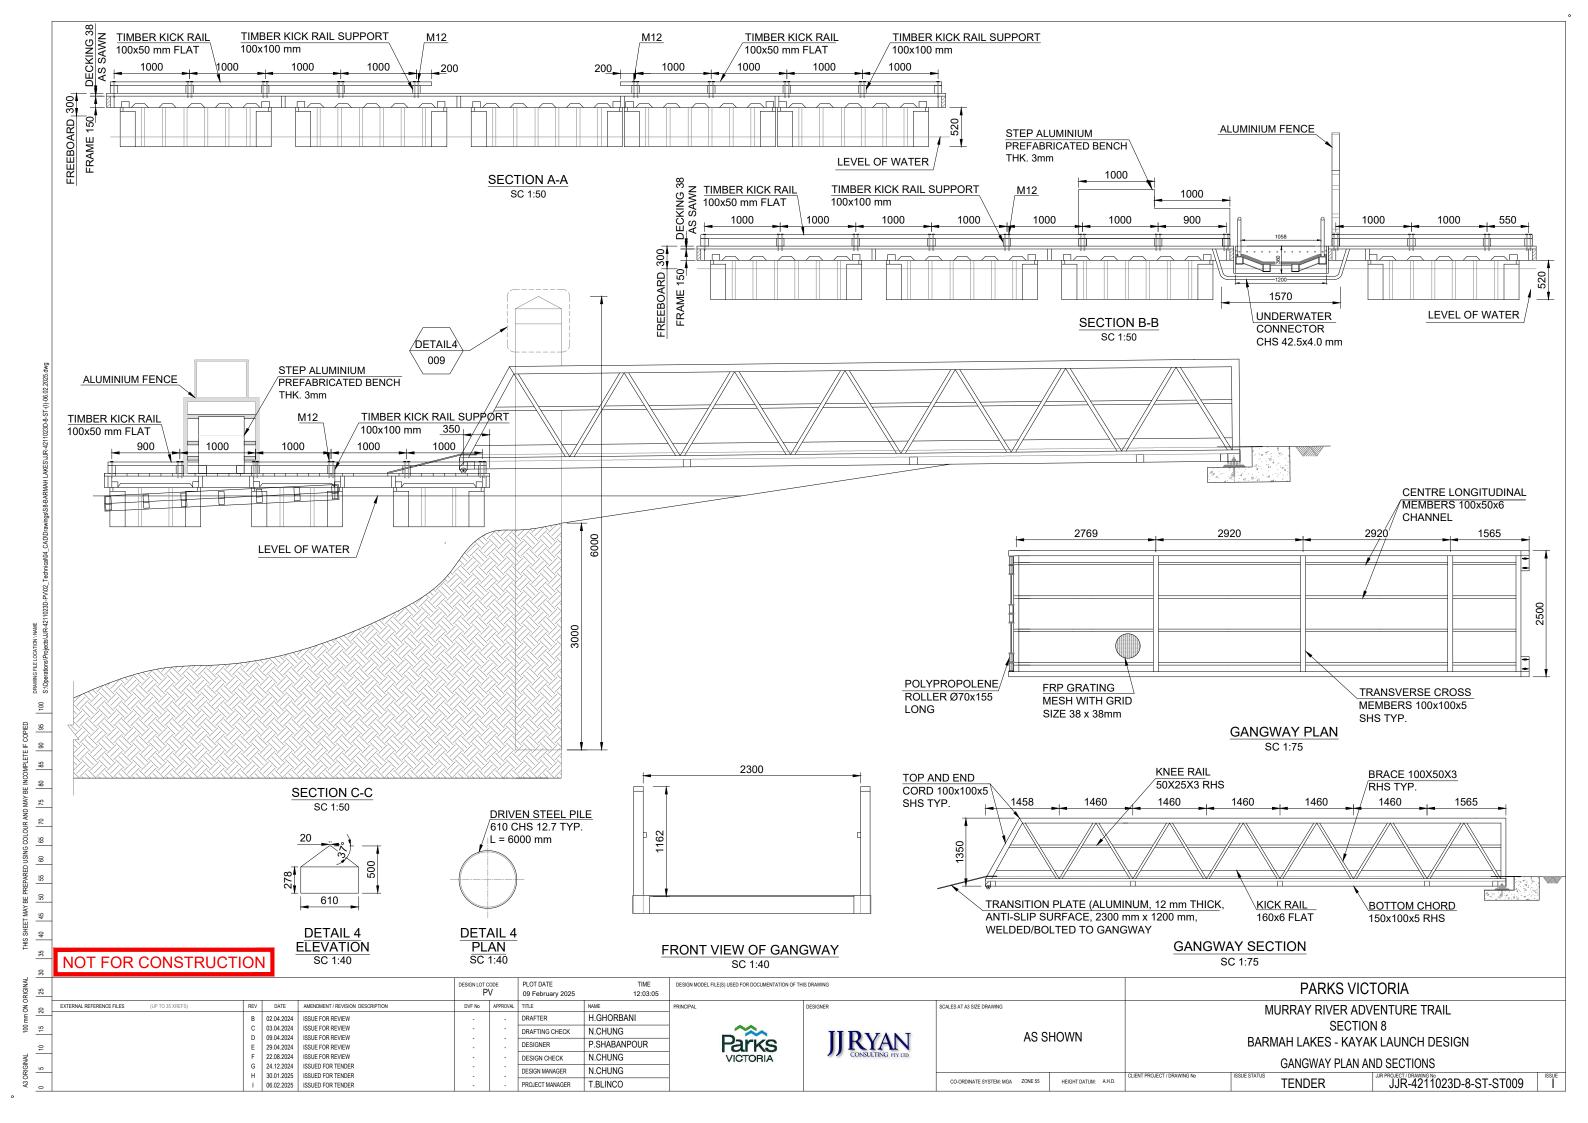
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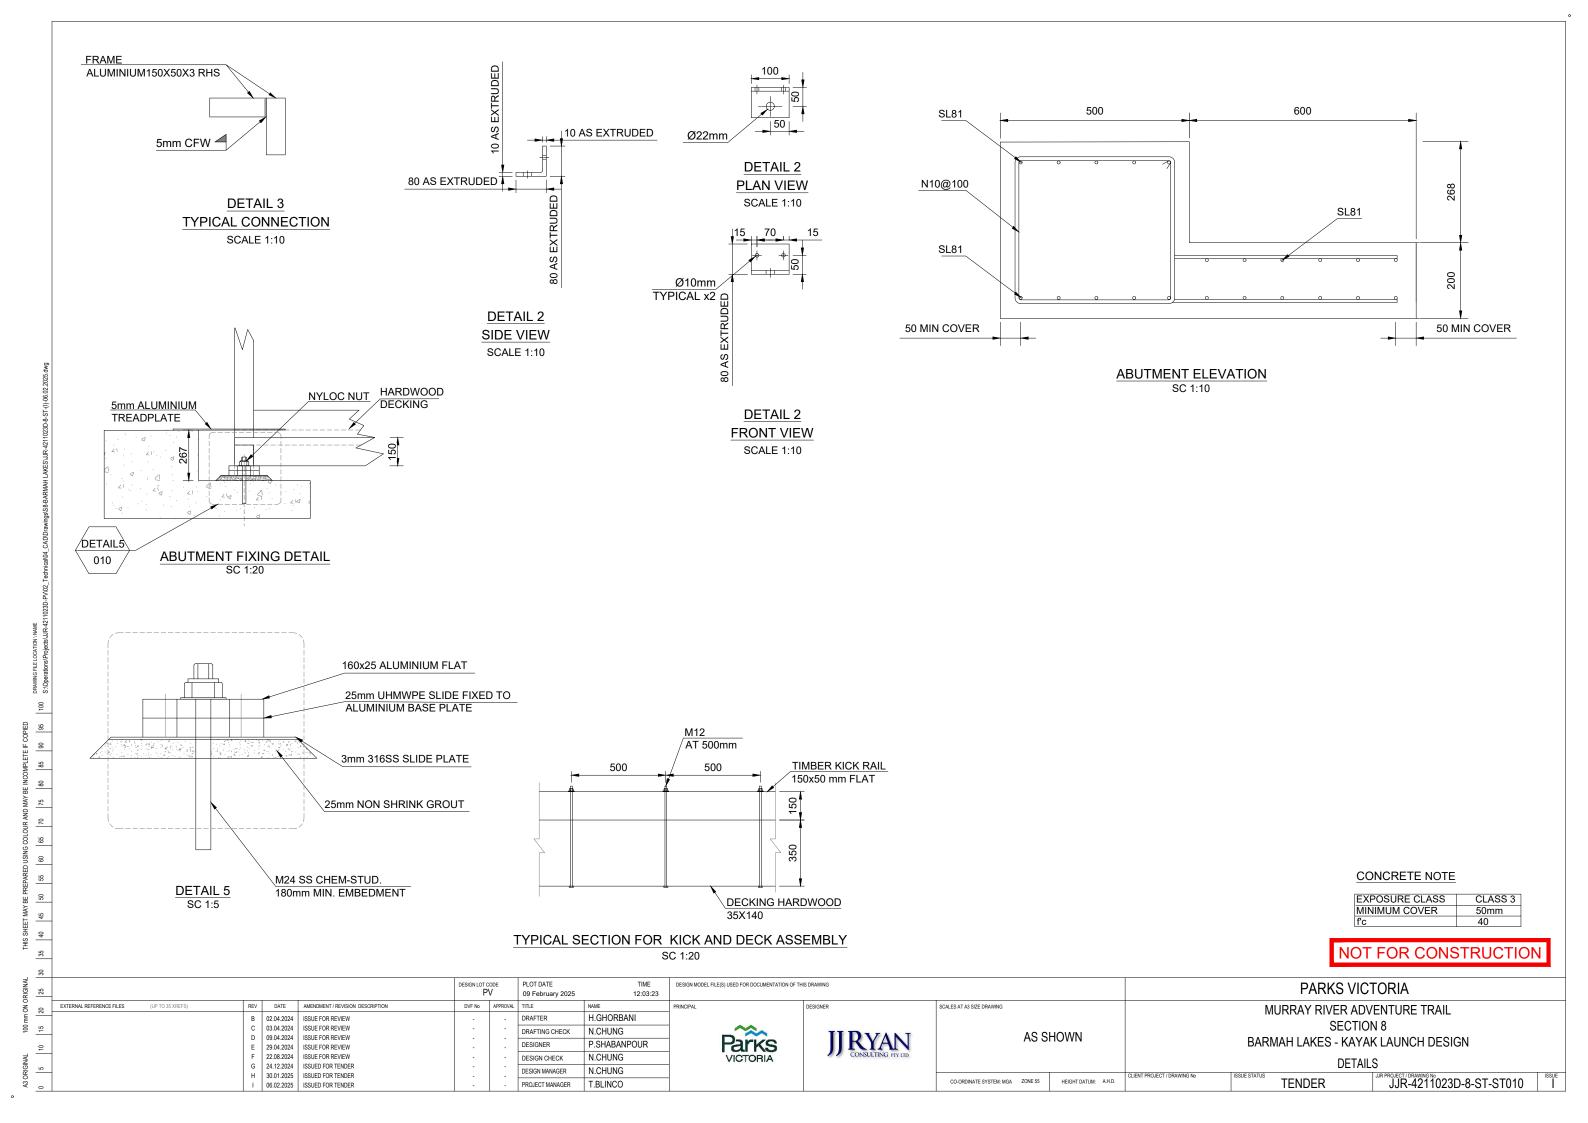
SCALE 1:25

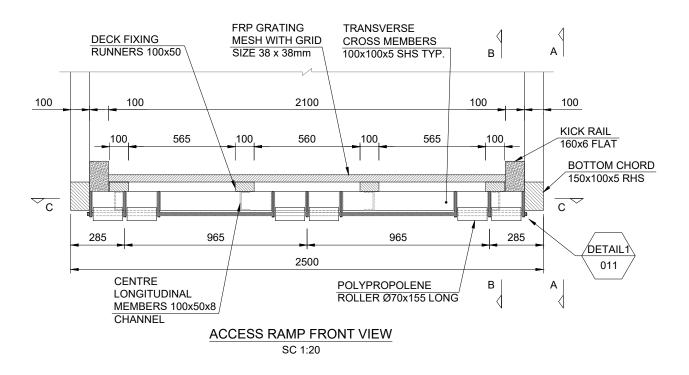
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- 2. FLOTATION MODULES ARE MANUFACTURED FROM U.V. STABILISED, HIGH STRESS CRACK RESISTANT, LINEAR POLYETHYLENE.
- 3. STANDARD COLOR BLACK.
- 4. FLOATS CAN BE FILLED WITH WATER OR CONCRETE TO ADD BALLAST TO INCREASE STABILITY. BALLAST CAN ALSO BE USED TO RAISE AND LOWER THE FLOAT FOR DIFFERENT FREEBOARD REQUIREMENTS. FLOATS CAN ALSO BE FOAM FILLED FOR EXTRA SECURITY IF REQUIRED.
- 5. STANDARD FLOATS ARE HOLLOW.
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- 7. DUE TO THE MANUFACTURING PROCESS, FLOAT DIMENSIONS MAY VARY.
- 8. ALL TIMBER MOORING POSTS SHALL BE OF F17 GRADE TIMBER, AS PER AS 1720.1.
- 9. ALL STEEL PILES SHALL BE OF GRADE G250 STEEL
- 10. THE MINIMUM EMBEDMENT DEPTH FOR STEEL PILES AND MOORING POSTS INTO THE SOIL SHALL BE 2.5~3m

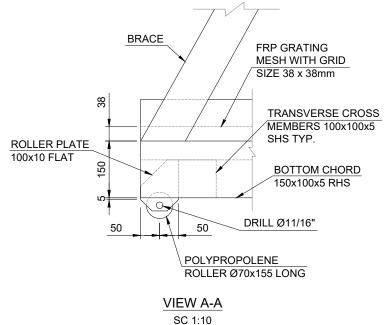
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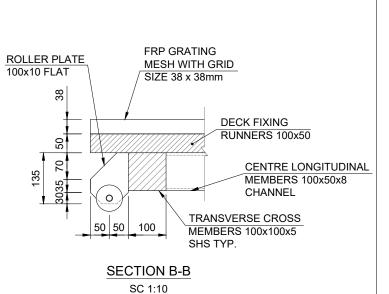
PARKS VICTORIA 12:02:45 09 February 2025 REV DATE AMENDMENT / REVISION DESCRIPTION EXTERNAL REFERENCE FILES SCALES AT A3 SIZE DRAWING MURRAY RIVER ADVENTURE TRAIL H.GHORBANI ISSUE FOR REVIEW SECTION 8 03.04.2024 ISSUE FOR REVIEW N.CHUNG DRAFTING CHECK **IIRYAN** AS SHOWN ISSUE FOR REVIEW 09.04.2024 **Parks** BARMAH LAKES - KAYAK LAUNCH DESIGN P.SHABANPOUR 29.04.2024 ISSUE FOR REVIEW ISSUE FOR REVIEW 22.08.2024 N.CHUNG DESIGN CHECK 24.12.2024 ISSUED FOR TENDER DESIGN MANAGER N.CHUNG ISSUED FOR TENDER 30.01.2025 CO-ORDINATE SYSTEM: MGA ZONE 55 JJR-4211023D-8-ST-ST008 **TENDER** 06.02.2025 ISSUED FOR TENDER PROJECT MANAGER T.BLINCO

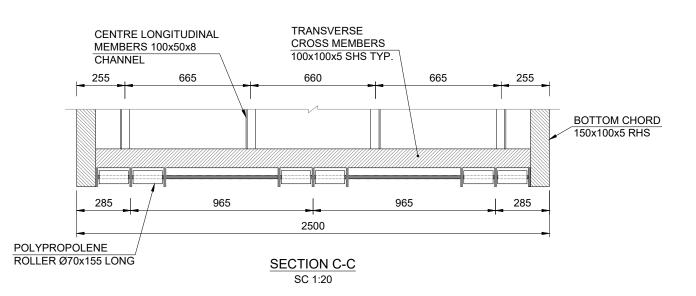




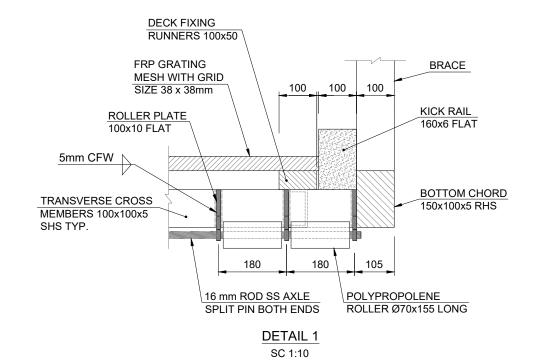








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9			E 29.04.2024	ISSUE FOR REVIEW	-	-	DESIGNER	P.SHABANPOUR		Parks	JJ RYAN CONSULTING PTY LITD			BANNAIT LAKES - KATAN LAUNCIT DESIGN		
₹			F 22.08.2024	ISSUE FOR REVIEW	-	-	DESIGN CHECK	N.CHUNG		VICTORIA	CONSULTING PTY LTD					
S G			G 24.12.2024	ISSUED FOR TENDER	-	-			_	VIOTOTIN				ACCESS RAMP DETAIL		
R			H 30.01.2025	ISSUED FOR TENDER	-		DESIGN MANAGER	N.CHUNG					CLIENT PROJECT / DRAWING No	ISSUE STATUS	JJR PROJECT / DRAWING No ISSUE	
- A3			I 06.02.2025	ISSUED FOR TENDER	-	-	PROJECT MANAGER	T.BLINCO				CO-ORDINATE SYSTEM: MGA ZONE	55 HEIGHT DATUM: A.H.D.	TENDER	JJR-4211023D-8-ST-ST011	